

RENTAL, SALES & SERVICE


Crew Quarters

- Crew quarters arrive ready for immediate action
- First rate living conditions in the most extreme circumstances
- Keep your team comfortable and close to the jobsite
- Manage your team around the clock



Crew Quarter Features

- 2 bedrooms, 2 bathrooms, sleeps 10
- Fully furnished, flatware and bedding
- Complete kitchen with microwave & oven
- Dedicated wash room with washer and dryer
- Flat screen televisions with satellite

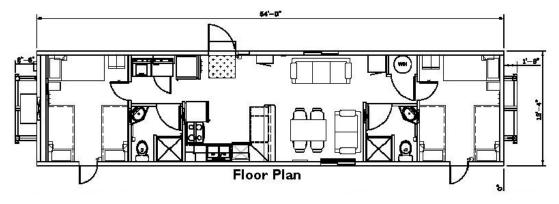




Kitchen



Bedroom

- Fully equipped 10 person accommodation
- Single unit package requires minimum 65 KVA
- Freight TBD by location
- Water and Septic can accommodate up to four units

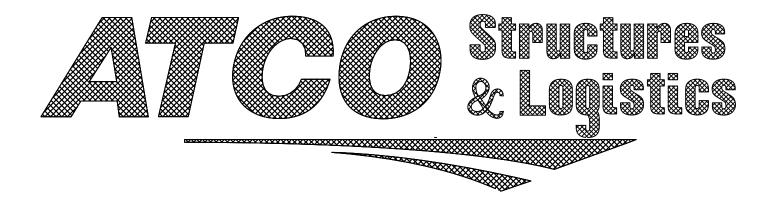

BUILDING CODES/COLORADO

- 1. INTERNATIONAL RESIDENTIAL CODE CODE 2006 ed. 2. NATIONAL ELECTRICAL CODE 2008 ed.
- 3. INTERNATIONAL PLUMBING CODE 2006 ed. 4. INTERNATIONAL MECHANICAL CODE 2006 ed.
- 5. INTERNATIONAL ENERGY CONSERVATION CODE 2009

OCCUPANCY LOAD — CONSTRUCTION TYPE -FLOOR LIVE LOAD -- 50 PSF - 100 PSF ROOF LIVE LOAD -=110 MPH 3 SEC. GUST SIESMIC ZONE -

- 1. STAIRS, RAMPS, ETC. BY OTHERS
- 2. ON PANEL BOX USE #4 BARE COPPER WIRE FROM GROUNDING LUG ON PANEL BOX TO SOLDERLESS GROUNDING BOLT THRU FRAME. EMPTY 1/2" PVC RACEWAY. (SAME LENGTH AS ENTRANCE) FOR CUSTOMER INSTALLED
- 3. SERVICE GROUND BY OTHERS AS PER AS PER 2008 NEC (ARTICLE 250)
- 4. THE COMPLETED DATA PLATE IS ATTACHED IN THE VICINITY OF THE ELECTRICAL PANEL BOX, STATE LABEL IS AFFIXED TO THE BUILDING ON THE BOTTOM LEFT SIDE OF THE REAR WALL OF THE BUILDING
- 5. PLUMBING FACILITIES MUST BE PROVIDED IN A ADJAJENT BUILDING ON THE SAME PROPERTY AS PER LOCAL BUILDING DEPARTMENT

ATCO


13'-4"x 40' CREW QUARTERS PROJECT # 94383

> THIS BULIDING IS INTENDED FOR USE AS SLEEPING QUARTERS FOR 4 PEOPLE NO MORE THAN 4 OCCUPANT AT A TIME

DRAWING INDEX					
CS	COVER SHEET				
AA01	EQUIPMENT & LIST PAGE				
A01	CONSTRUCTION PAGE				
A02	FLOOR LAYOUT & CABINET DETAIL				
ELEV	ELEVATIONS				
D01	CROSS SECTION				
E01	ELECTRICAL LAYOUT				
E02	ELECTRICAL LEGEND CALCULATIONS				
	AND PANEL SHEDULES				
M01	PLUMBING LAYOUT				
	& SCHEMATICS				
E02	CROSS SECTION ELECTRICAL LAYOUT ELECTRICAL LEGEND CALCULATIONS AND PANEL SHEDULES PLUMBING LAYOUT				

				NOTE
-				NOTE
ø	11JAN12	ISSUE FOR STATE REVIEW	GS	
REV	DATE	DESCRIPTION	BY	

CUSTOMER ACCEPTANCE	
☐ — ACCEPTANCE AS DRAWN	
☐ — ACCEPTANCE EXCEPT AS NOTED	DRAWN
BY:	CHECK
	DATE:
DATE:	SCALE:

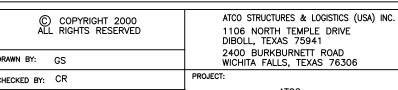


13'-4"X40'

CREW QUARTERS

13DEC11


SPECIFICATION NUMBER 610138-05CQ DRAWING TITLE: COVER SHEET DRAWING NO: 94383-01-CS




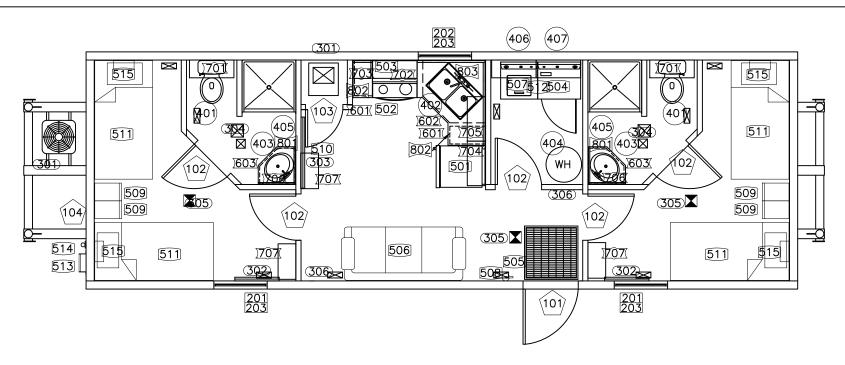


	NO.	QTY.	SIZE	ITEM	DESCRIPTION		NO.	QTY.	SIZE	ITEM	DESCRIPTION
RS	101	1	36X80	EXTERIOR DOOR	20 GA PRE HUNG STEEL DOOR W/ 10X10 VP HARDWARE: (2) KASON COOLER/FREEZER HARDWARE (1)DEADBOLT (1)CHECKCHAIN	NGS	501 502	1 1	16.5 CU FT -	REFRIGERATOR RANGE	16.5 CU FT REFRIGERATOR 30" DOMESTIC RANGE
DOORS	102	5	30X80	INTERIOR DOOR	IMPERIAL OAK H.C. DOOR W/ METAL FRAME HARDWARE: (2) PRIVACY KNOB, (3) PASSAGE KNOB	FURNISHINGS	503 504	1 1	_	HOOD DRYER	MICROWAVE W/ VENT HOOD HEAVY DUTY DRYER
100/	103	1	24X80	INTERIOR DOOR	IMPERIAL OAK H.C. DOOR W/ METAL FRAME HARDWARE:(1) PASSAGE KNOB	FUR	505 506	1 1	31x36 —	PAN COUCH	ENTRY PAN W/ RUBBER MAT 3 PERSON NAGAHYDE COUCH
	104	1	_	BOX	LOCK BOX		507 508	1 1	_ #5	WASHER EXTINGUISHER	HEAVY DUTY AUTOMATIC WASHER #5 ABC FIRE EXTINGUISHER
						500	509	4	_	LOCKER	12X18X72 SINGLE METAL LOCKER
WINDOWS	201 202 203	2 1 3	36X60 36X36 —	WINDOW WINDOW BLINDS	INSULATED V.S. WHITE VINYL W/SCREEN— ARGON— EGRESS INSULATED V.S. WHITE VINYL W/SCREEN— ARGON VINYL MINI BLINDS		510 511 512	1 4 1	32 _ _	TELEVISION BED SHELVING	32" FLAT PANEL TELEVISION 36"X80" BED W/INNERSPRING MATTRESS & DRAWER BASE WIRE SHELVING
200 201							513 514 515	1 1 4		LADDER POLE SHELF/LIGHT	TUBULAR LADDER STEEL TELESCOPING SATELLITE POLE PERSONAL SHELF/LIGHT COMBO
MECHANICAL	301	1	15KW	HVAC	SPLIT SYSTEM 2.5 COOLING, 15KW HEAT, CLOSET MOUNT, <u>SEALED</u> GALVANIZED IN FLOOR DUCTWORK W/SUPPLY AIR GRILLES, GRILLES OVER DOORS; PROTECTIVE COVER OVER CONDENSER	CABINETS	601	2	B12	CABINET	BASE CABINET
300	302 303 304	2 1 2	500W 1000W 75 CFM	HEATER HEATER FAN	BASEBOARD HEATER W/ INTEGRAL TSTAT BASEBOARD HEATER W/ INTEGRAL TSTAT EXHAUST FAN	85 88 88 88	602	1 2	SBDC42 SPVDC2435	CABINET CABINET	BASE CABINET BASE CABINET
300	305 306	3 2	120V 9V	DETECTOR DETECTOR	INNERCONNECTED SMOKE DETECTOR W/ BATTERY BACKUP CO DETECTOR	ETS	701	2	W2724	CABINET	WALL CABINET
DLUMBING 00	401 402 403 404 405 406	2 1 2 1 2	- - - 80 USG 36	WATER CLOSET SINK LAVATORY WATER HEATER SHOWER OUTLET	STANDARD WATER CLOSET W/ OPEN FRONT SEAT DOUBLE COMPARTMENT STAINLESS STEEL SINK COUNTER MOUNT LAVATORY 80 GALLON ELECTRIC WATER HEATER FIBERGLASS SHOWER WASHER OUTLET W/ VALVES	O WALL CABINETS	702 703 704 705 706 707	1 1 1 1 2 3	W301815 W1230 W3012 W3030 - W2418	CABINET CABINET CABINET CABINET CABINET CABINET CABINET	WALL CABINET WALL CABINET WALL CABINET WALL CABINET CORNER MEDICINE CABINET W/ MIRROR WALL CABINET NO DOOR
	407	1	_	VENT	DRYER VENT	00 C-T0PS	801 802 803	2 2 1	2'-1" 1'-1" 3' 10-3/4"	COUNTERTOP COUNTERTOP COUNTERTOP	P'LAM COUNTERTOP P'LAM COUNTERTOP P'LAM COUNTERTOP


	NOTES:	CUSTOMER ACCEPTANCE - ACCEPTANCE AS DRAWN - ACCEPTANCE EXCEPT AS NOTED	© COPYRIGHT 2000 ALL RIGHTS RESERVED	ATCO STRUCTURES & LOGISTICS (USA) INC. 1106 NORTH TEMPLE DRIVE DIBOLL, TEXAS 75941 2400 BURKBURNETT ROAD	610138-05CQ	
		BY:	DRAWN BY: GS CHECKED BY: CR	WICHITA FALLS, TEXAS 76306 PROJECT:	– EQUIMPENT PAGE	ATCO & Logistics
11JAN12 ISSUE FOR STATE REVIEW DATE DESCRIPTION	GS BY	DATE:	DATE: 13DEC11 SCALE: NTS	ATCO 13'-4"X40' CREW QUARTERS	DRAWING NO: 94383-01-AA01	

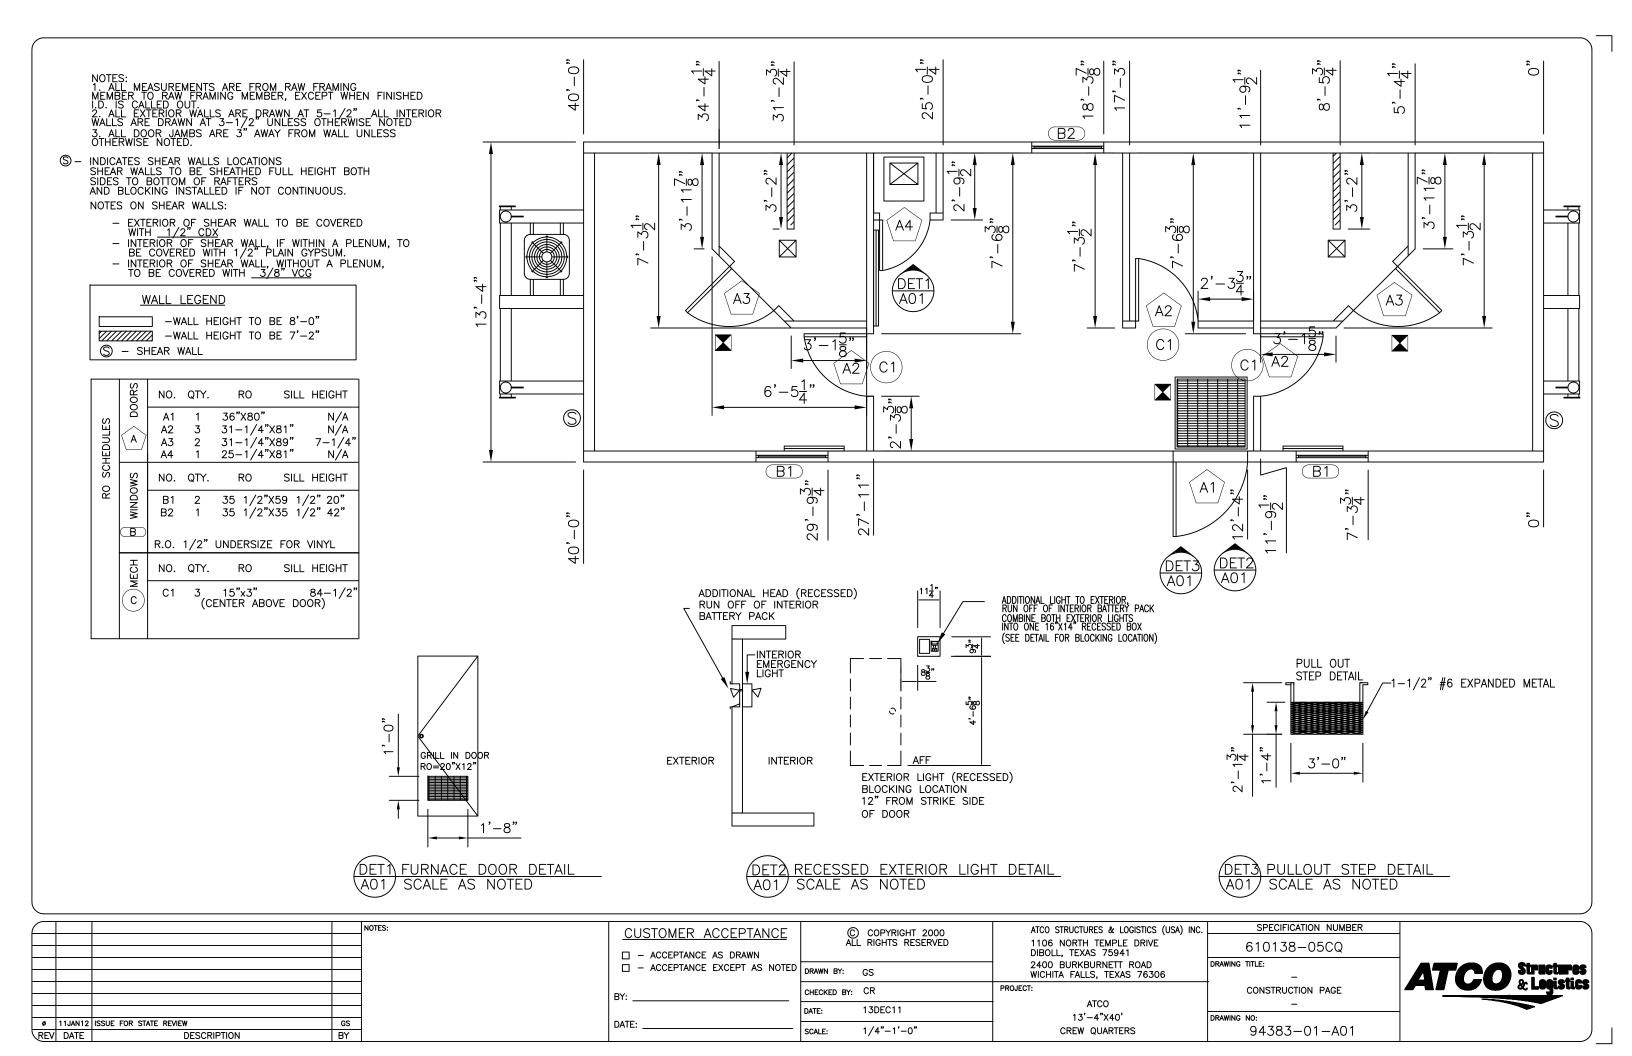


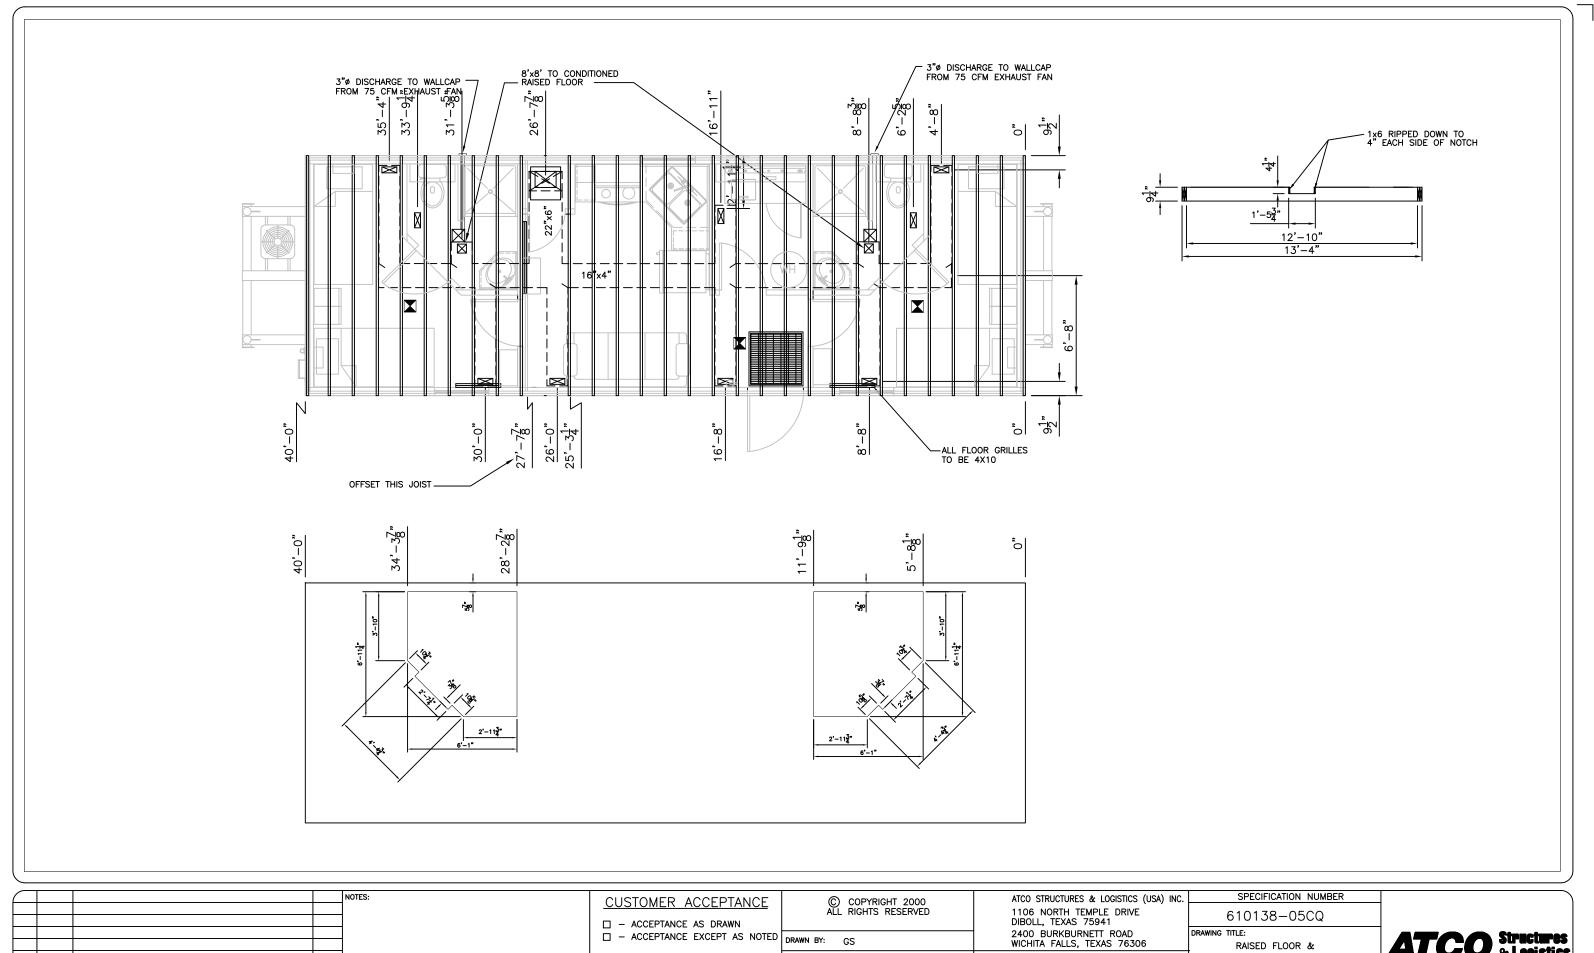



	☐ — ACCEPTANCE AS DRAWN	· A	LL RIGHTS RESERVED	1106 NORTH TEMPLE DRIVE DIBOLL, TEXAS 75941	610138-05CQ	
	☐ — ACCEPTANCE EXCEPT AS NO	ED DRAWN BY:	GS	2400 BURKBURNETT ROAD WICHITA FALLS, TEXAS 76306	DRAWING TITLE: RAISED FLOOR &	ATCO Structures & Logistics
	BY:	CHECKED BY	: CR	PROJECT:	VENTILATION LAYOUT	A Logistics
		DATE:	13DEC11	ATCO 13'-4"X40'	DRAWING NO:	
11JAN12 ISSUE FOR STATE REVIEW GS / DATE DESCRIPTION BY	DATE:	SCALE:	NTS	CREW QUARTERS	94383-01-A02	

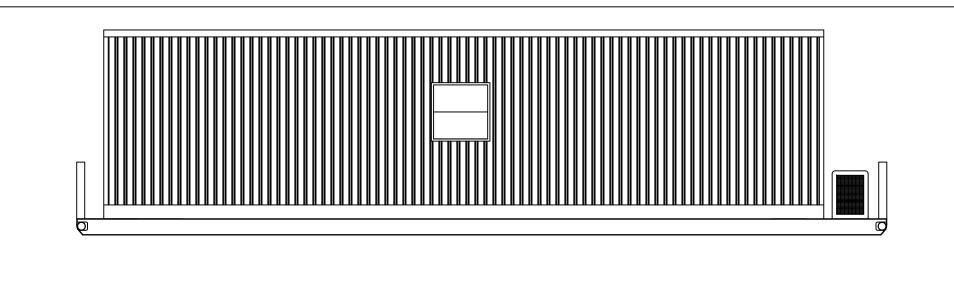

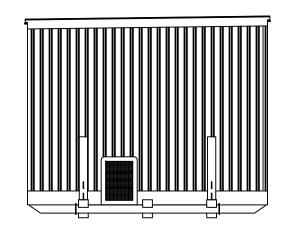

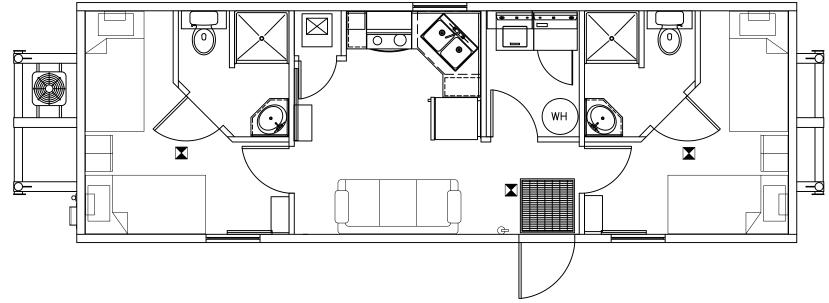

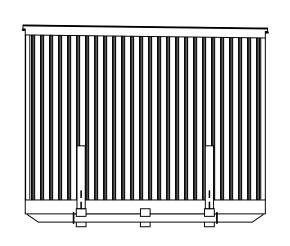

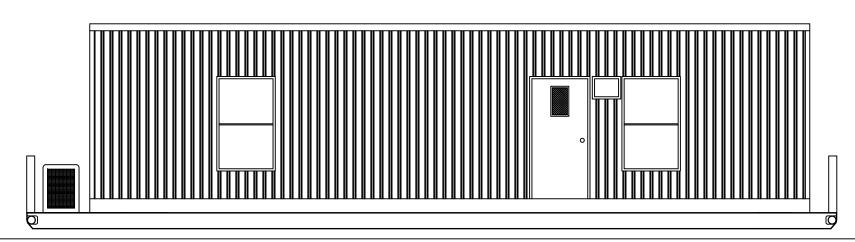

				NOTES:
ø	11JAN12	ISSUE FOR STATE REVIEW	GS	
REV	DATE	DESCRIPTION	BY	

CUSTOMER ACCEPTANCE

□ − ACCEPTANCE AS DRAWN
□ − ACCEPTANCE EXCEPT AS NOTED DRAWN BY: GS

BY: _____

© COPYRIGHT 2000 ALL RIGHTS RESERVED

DRAWN BY: GS

CHECKED BY: CR

DATE: 13DEC11

NTS

ATCO STRUCTURES & LOGISTICS (USA) INC. 1106 NORTH TEMPLE DRIVE DIBOLL, TEXAS 75941 2400 BURKBURNETT ROAD WICHITA FALLS, TEXAS 76306

2400 BURKBURNETT ROAD WICHITA FALLS, TEXAS 76306

PROJECT:

ATCO
13'-4"X40'

CREW QUARTERS

610138-05CQ

DRAWING TITLE:


ELEVATIONS

DRAWING NO:

94383-01-ELEV

SPECIFICATION NUMBER



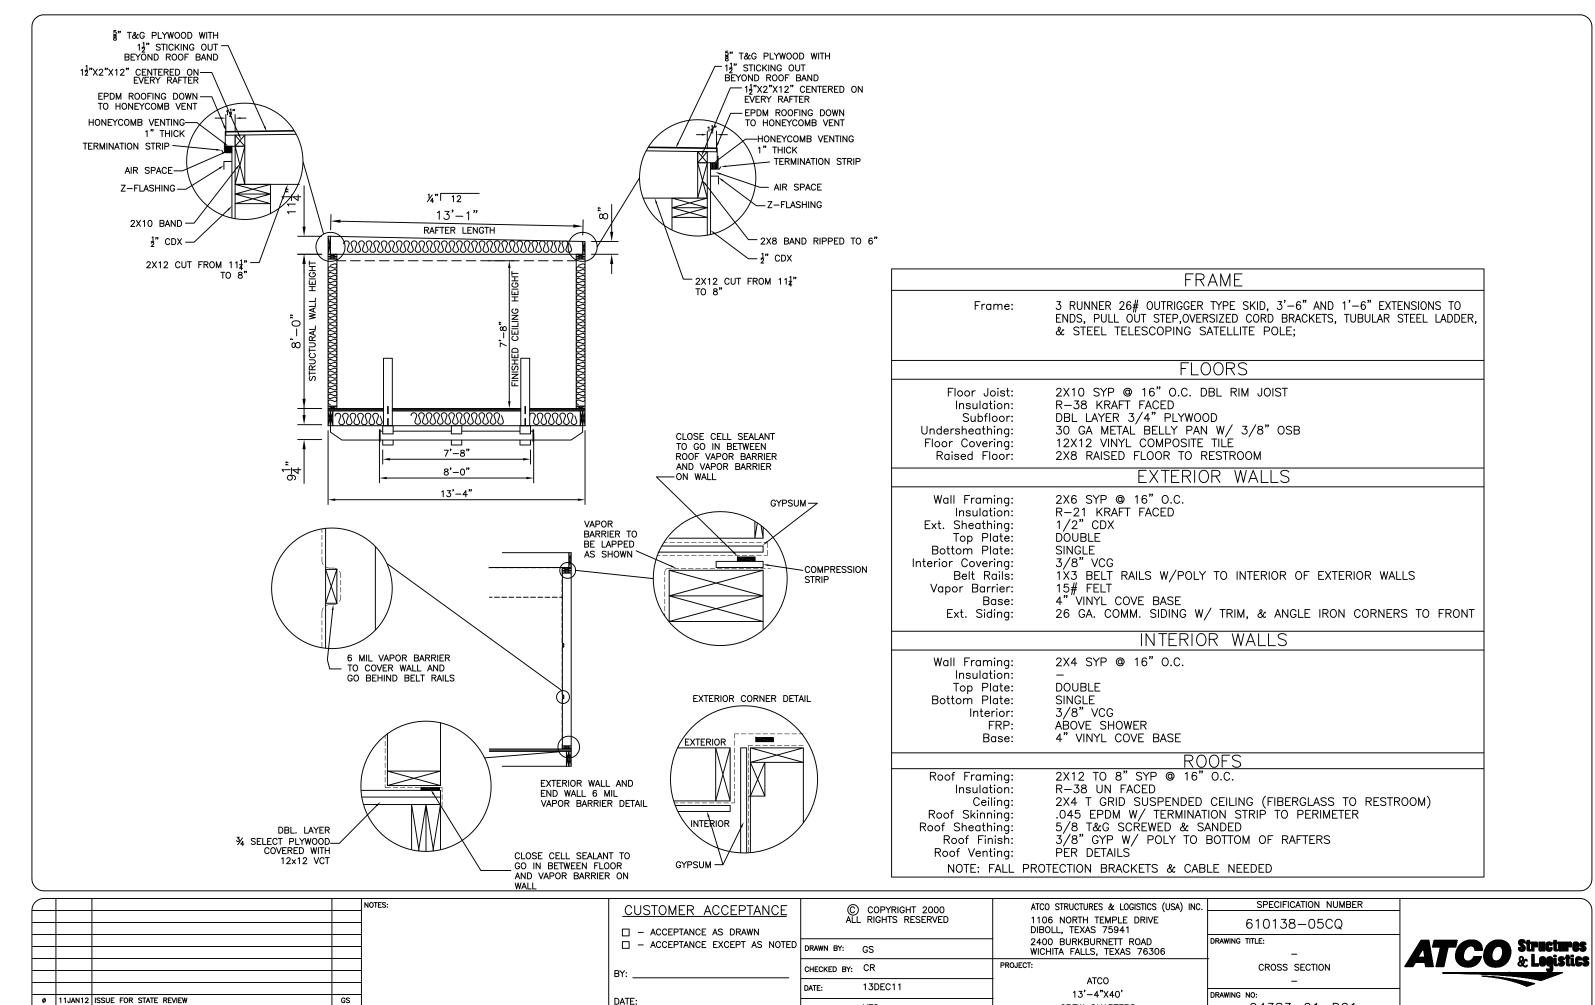


NTS

DESCRIPTION

REV DATE

CREW QUARTERS

94383-01-D01

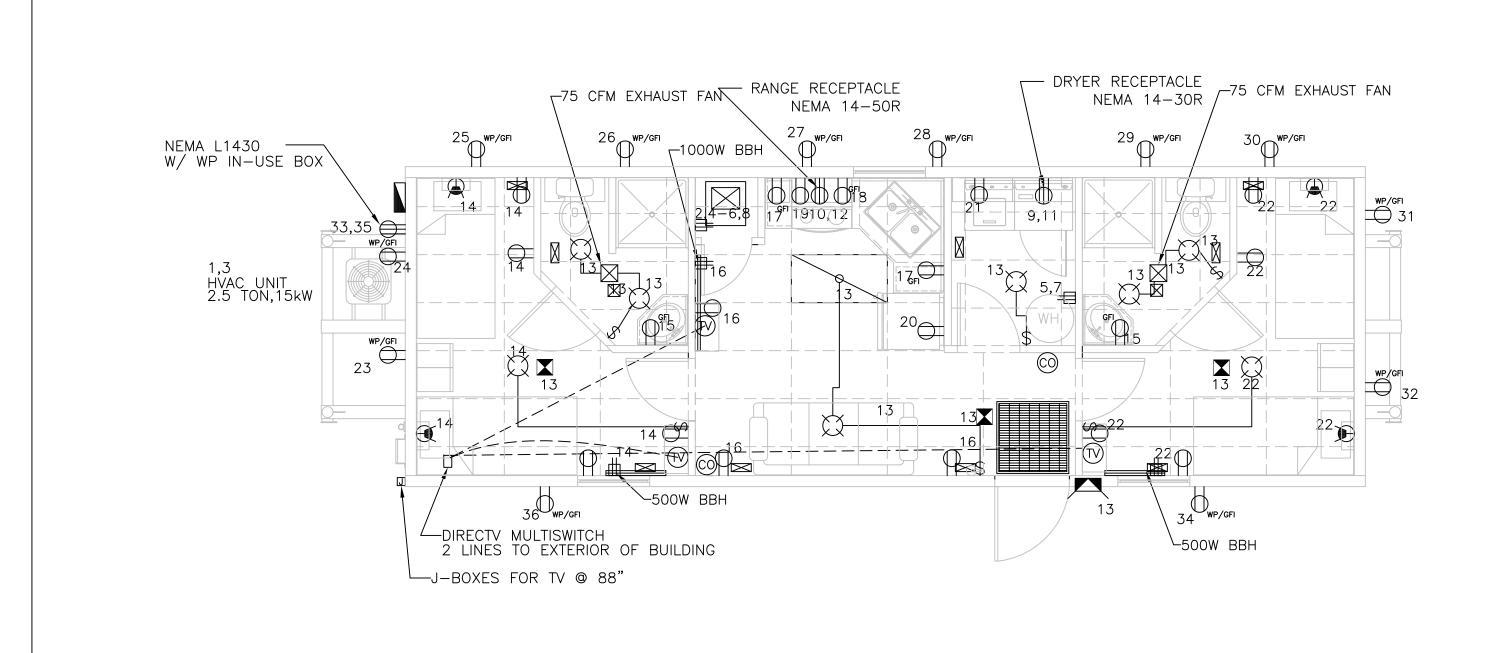

NC	CUSTOMER ACCEPTANCE - ACCEPTANCE AS DRAWN - ACCEPTANCE EXCEPT AS NOTE	ALL RIGHTS RESERVED	ATCO STRUCTURES & LOGISTICS (USA) INC. 1106 NORTH TEMPLE DRIVE DIBOLL, TEXAS 75941 2400 BURKBURNETT ROAD WICHITA FALLS, TEXAS 76306	SPECIFICATION NUMBER 610138-05CQ DRAWING TITLE:	ATCO Structures
	BY:	CHECKED BY: CR	PROJECT:	ELECTRICAL LAYOUT	AI CO & Logistics
6 11JAN12 ISSUE FOR STATE REVIEW GS REV DATE DESCRIPTION BY	DATE:	DATE: 13DEC11 SCALE: NTS	ATCO 13'-4"X40' CREW QUARTERS	DRAWING NO: 94383-01-E01	


SYMBOL	LEGEND & LOADS					
SYMBOL	DESCRIPTION	#	LOAD	AMPS	LUMENS	EFFICACY LUMENS/WATT
8	2' x 4' T-8 FLUORESCENT TROFFER C/W 4@32W ES LAMPS - MAGNETIC BALLAST	1	124W	1.16A	2900	85.29
	EXTERIOR WP WALL LIGHT C/W 70W HPS LAMP & SWITCH CONTROL-LOW PROFILE	1	70W	0.58A	N.A.	N.A.
9 (SHELF/LIGHT COMBO	4	-	-	N.A.	N.A.
Ø	INC. GLOBE C/W 60W A19 LAMP	8	60W	0.50A	N.A.	N.A.
×	120V SMOKE DETECTOR W/ BATTERY BACKUP	3	-	-	-	_
\boxtimes	EXHAUST FAN-cfm AS NOTED	2	99W	0.83A	N.A.	N.A.
	POWER PANEL - NEMA3R	1	-	-	-	_
\$	20A/125V SINGLE POLE SWITCH	6	-	-	-	_
-	20A/125V DUPLEX RECEPTACLE	14	180W	1.5A	-	-
GF	20A/125V CLASS 'A' GFCI RECEPTACLE	5	180W	1.5A	-	-
WP/GFI	20A/125V CLASS 'B' GFCI RECEPTACLE	12	180W	1.5A	-	-
€ (50)	30A(50A)/125/250V NEMA 14-30R RECEPTACLE	2	4.0kW	16.67A	-	-
#	HARD WIRED CONNECTION	5	-	-	-	-
•	DATA OUTLET C/W 1/2" FLEX STUB UP	-	-	-	-	-
<u>©</u>	9V CO DETECTOR @12" AFF	2	N.A.	N.A.	-	-
₩	TV OUTLET C/W RG6 CABLE BACK TO SAT. JB	3	N.A.	N.A.	-	-
N.A.	WATER HEATER	1	4.50kW	18.75	-	-
	500W BASEBOARD HEATER C/W B.I.T.	2	500W	4.16A	-	-
	1000W BASEBOARD HEATER C/W B.I.T.	1	1000W	8.33A	-	_

LOAD CALCULATION TOTAL COMPLEX	_
<u>LP-1</u> LIGHTING LOAD =533sqft x 3.0VA APPLIANCE LOAD =	1 590 VA 3 000 VA
HEATING LOAD 1@15kW =	15 000 VA
DHW HEATER LOAD = DRYER LOAD =	4 500 VA 4 000 VA
RANGE LOAD =	9 000 VA
COMPLEX TOTAL LOAD = APPLICATION OF DEMAND FACTOR	37 090 VA
10 000 VA @ 100% 27 090 VA @ 40% MINIMUM SERVICE SIZE	10 000 VA 10 836 VA
20 836 VA/240V =	86.81A

NOTES:

- 1. WIRING METHOD TO BE MC CABLE, COPPER, MINIMUM #12AWG. 2. BLANK SPACES IN PANEL MAY BE OMITTED TO MAKE USE OF SMALLER PANELS. BREAKER SIZE AND QUANTITY SHALL REMAIN THE SAME. 3. ALL ELECTRICAL CONNECTIONS TO BE MOUNTED 14" AFF UNLESS OTHERWISE SPECIFIED. ALL HEIGHTS ARE MEASURED TO
- THE BOTTOM OF THE BOX. 4. TELE/DATA OUTLETS ARE TO HAVE A 3/4" FLEXIBLE CONDUIT STUBBED UP INTO THE CEILING SPACE UNLESS NOTED. 5. ALL CONDUIT TO CONTAIN AN INSULATED GROUND CONDUCTOR SIZED AS REQUIRED BY 2008 N.E.C., MINIMUM #14 AWG.
- 6. ELECTRICAL INSTALLATION SHALL BE IN COMPLIANCE WITH 2008 N.E.C..
- 7. ALL WIRING IN RETURN AIR PLENUMS SHALL MEET RATING REQUIREMENTS OF 2008 N.E.C..
- 8. MOUNTING HEIGHTS FOR ALL WALL MOUNTED DEVICES SHALL BE FROM FINISHED FLOOR TO BOTTOM OF DEVICE BOX.
- 9. ALL 125 VOLT, 15 & 20 AMP RECEPTACLES SHALL BE LISTED TAMPER-RESISTANT RECEPTACLES (2008-NEC, ART.406-11)
- 10. ALL CIRCUITS SHALL BE PROTECTED BY A LISTED ARC-FAULT CIRCUIT INTERUPTER (COMB. TYPE)
- 11. REMOVE ALL GROUNDING BONDS FROM APPLIANCES.
- 12. SMOKE DETECTORS ARE THE BE INNERCONNECTED.

STANDARD OUTLET MOUNT height in inches to bottom unless otherwise noted	NG HEIGHTS of box
ELECTRICAL BOX TYPE	MOUNTING HEIGHT
RECEPTACLE	16
SWITCH	44
MICROWAVE RECEPTACLE	75
TV (top of box)	60
ANTENNA BOX	88
COUNTERTOP RECEPTACLE	44
LOWER BUNK LIGHT	40
UPPER BUNK LIGHT	83
BUNK LIGHT DIMMER	38
STOVE	16
PHONE	44
TELE/DATA	16
WATER HEATER	48
EXTERIOR LIGHT	78
EXTERIOR RECEPTACLE	16
WASHER	36
DRYER	36
THERMOSTAT(to centreline)	60
RADIO IN CABINET	58

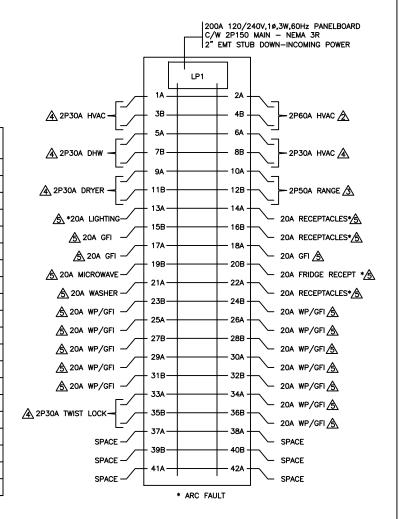

WIRING LEGEND

1 - 4 AWG THHN WIRE

3 - 8 AWG THHN WIRE

A - 10 AWG THHN WIRE

⚠ - 12 AWG THHN WIRE

6 - 14 AWG THHN WIRE

				NOTES
				1
				-
ø	11JAN12	ISSUE FOR STATE REVIEW	GS	1
REV	DATE	DESCRIPTION	BY	

CUSTOMER ACCEPTANCE □ - ACCEPTANCE AS DRAWN ☐ — ACCEPTANCE EXCEPT AS NOTED DRAWN BY:

© COPYRIGHT 2000 ALL RIGHTS RESERVED

13DEC11

CHECKED BY: CR

ATCO STRUCTURES & LOGISTICS (USA) INC. 1106 NORTH TEMPLE DRIVE DIBOLL, TEXAS 75941 2400 BURKBURNETT ROAD WICHITA FALLS, TEXAS 76306

ATCO

13'4"X40' CREW QUARTERS


PROJECT:

610138-05CQ DRAWING TITLE: ELECTRICAL PANEL, SCHEDULE, CALCS, & LEGEND

94383-01-E02

SPECIFICATION NUMBER



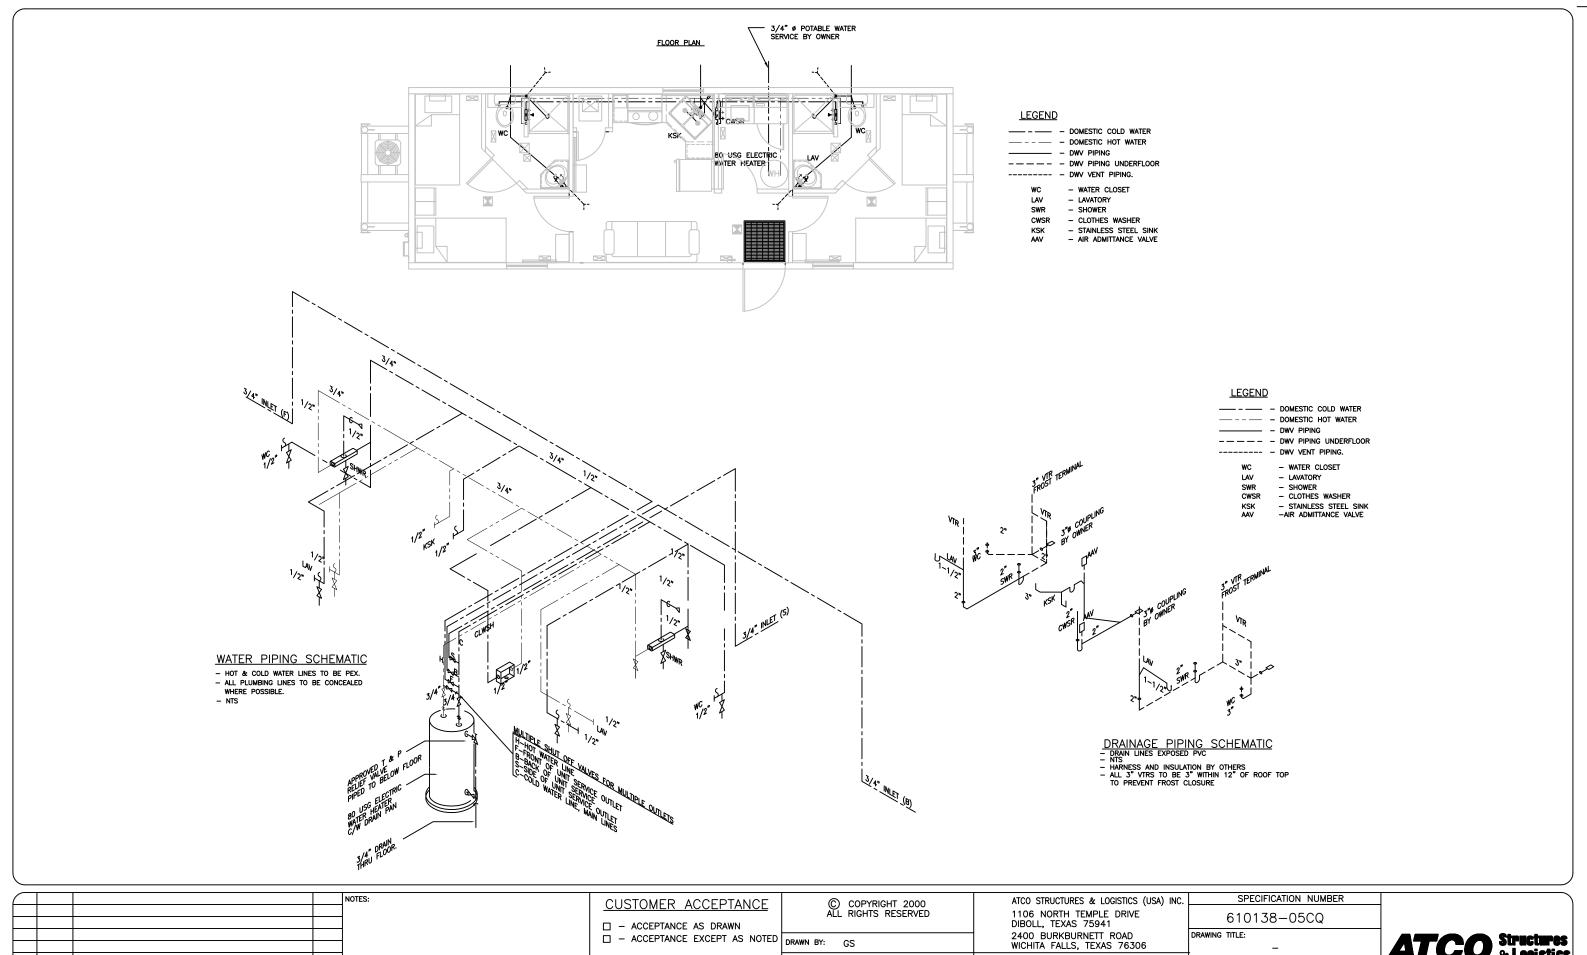

				CUSTOMER ACCEPTANCE	
				☐ — ACCEPTANCE AS DRAWN	
				☐ — ACCEPTANCE EXCEPT AS NOTED	DRAWN B
				BY:	CHECKED
					DATE:
ø	11JAN12	ISSUE FOR STATE REVIEW	GS	DATE:	2011 5
\REV	DATE	DESCRIPTION	BY		SCALE:

© COPYRIGHT 2000 ALL RIGHTS RESERVED	ATCO STRUCTURES & LOGISTIC 1106 NORTH TEMPLE DRIN DIBOLL, TEXAS 75941
N BY: GS	2400 BURKBURNETT ROAD WICHITA FALLS, TEXAS 763
KED BY: CR	PROJECT:
1705011	ATCO

13'-4"X40'

CREW QUARTERS

13DEC11

NTS

	610138-05CQ
	DRAWING TITLE:
6	_
	PLUMGING LAYOUT
	& SCHEMATICS
	DRAWING NO:
	94383-01-M01





REScheck Software Version 4.4.2 Compliance Certificate

Project Title: 94383 13'4"x40' Atco Crew Quarter

Energy Code:

Location:

2009 IECC Crested Butte, Colorado

Construction Type:

Single Family 3% 11292

Glazing Area Percentage: Heating Degree Days: Climate Zone:

Construction Site:

Owner/Agent:

Designer/Contractor:

Lupe Sandoval

ATCO Structures and Logistics 1106 North Temple Drive

Diboll, TX 75941

936-829-6052

Isandoval@atcoslusa.com

Compliance: Passes using UA trade-off

Compliance: 4.2% Better Than Code

Maximum UA: 95

Your UA: 91

The % Better or Worse Than Code index reflects how close to compliance the house is based on code trade-off rules.

It DOES NOT provide an estimate of energy use or cost relative to a minimum-code home.

Assembly	Gross Area or Perimeter	Cavity R-Value	Cont. R-Value	Glazing or Door U-Factor	UA
Floor 1: All-Wood Joist/Truss:Over Unconditioned Space	533	38.0	0.0		14
Wall 1: Wood Frame, 16" o.c.	853	21.0	0.0		46
Window 1: Vinyl Frame:Double Pane with Low-E	29			0.290	8
Door 1: Solid	20			0.350	7
Ceiling 1: Flat Ceiling or Scissor Truss	533	38.0	0.0		16

Compliance Statement: The proposed building design described here is consistent with the building plans, specifications, and other calculations submitted with the permit application. The proposed building has been designed to meet the 2009 IECC requirements in REScheck Version 4.4.2 and to comply with the mandatory requirements listed in the REScheck papection Checklist.

Name - Title

Project Title: 94383 13'4"x40' Atco Crew Quarter Data filename: R:\WIP\2011 WIP\(94383) 13'-4x40' CQ ATCO ALLY\For Colorado\94383 Res-Check.rck Report date: 01/11/12

Page 1 of 4



RES*check* Software Version 4.4.2 **Inspection Checklist**

	Ceilings:				
	Ceiling 1: Flat Ceiling or Scissor Truss, R-38.0 cavity insulation				
	Comments:				
	Above-Grade Walls:				
	Wall 1: Wood Frame, 16" o.c., R-21.0 cavity insulation				
	Comments:				
	Windows:				
	Window 1: Vinyl Frame:Double Pane with Low-E, U-factor: 0.290				
	For windows without labeled U-factors, describe features:				
	#Panes Frame Type Thermal Break? Yes No				
	Comments:				
	Doors:				
	Door 1: Solid, U-factor: 0.350				
	Comments:				
	Floors:				
	Floor 1: All-Wood Joist/Truss:Over Unconditioned Space, R-38.0 cavity insulation				
	Comments:				
	Floor insulation is installed in permanent contact with the underside of the subfloor decking.				
	Air Leakage:				
	Joints (including rim joist junctions), attic access openings, penetrations, and all other such openings in the building envelope that are				
	sources of air leakage are sealed with caulk, gasketed, weatherstripped or otherwise sealed with an air barrier material, suitable film or solid material.				
	Air barrier and sealing exists on common walls between dwelling units, on exterior walls behind tubs/showers, and in openings between				
_	window/door jambs and framing.				
	Recessed lights in the building thermal envelope are 1) type IC rated and ASTM E283 labeled and 2) sealed with a gasket or caulk				
	between the housing and the interior wall or ceiling covering. Access doors separating conditioned from unconditioned space are weather-stripped and insulated (without insulation compression or				
_	damage) to at least the level of insulation on the surrounding surfaces. Where loose fill insulation exists, a baffle or retainer is installed				
	to maintain insulation application.				
	Wood-burning fireplaces have gasketed doors and outdoor combustion air.				
	Automatic or gravity dampers are installed on all outdoor air intakes and exhausts.				
	Air Sealing and Insulation:				
	Building envelope air tightness and insulation installation complies by either 1) a post rough-in blower door test result of less than 7 ACH at 50 pascals OR 2) the following items have been satisfied:				
	(a) Air barriers and thermal barrier: Installed on outside of air-permeable insulation and breaks or joints in the air barrier are filled or repaired.				
	(b) Ceiling/attic: Air barrier in any dropped ceiling/soffit is substantially aligned with insulation and any gaps are sealed.				
	(c) Above-grade walls: Insulation is installed in substantial contact and continuous alignment with the building envelope air barrier.				
	(d) Floors: Air barrier is installed at any exposed edge of insulation.				
	(e) Plumbing and wiring: Insulation is placed between outside and pipes. Batt insulation is cut to fit around wiring and plumbing, or sprayed/blown insulation extends behind piping and wiring.				
	(f) Corners, headers, narrow framing cavities, and rim joists are insulated.				

Project Title: 94383 13'4"x40' Atco Crew Quarter Data filename: R:\WIP\2011 WIP\(94383) 13'-4x40' CQ ATCO ALLY\For Colorado\94383 Res-Check.rck

(g) Shower/tub on exterior wall: Insulation exists between showers/tubs and exterior wall.

	Sunrooms:
	Sunrooms that are thermally isolated from the building envelope have a maximum fenestration U-factor of 0.50 and the maximum skylight U-factor of 0.75. New windows and doors separating the sunroom from conditioned space meet the building thermal envelope requirements.
	Materials Identification and Installation:
	Materials and equipment are installed in accordance with the manufacturer's installation instructions.
	Insulation is installed in substantial contact with the surface being insulated and in a manner that achieves the rated R-value.
	Materials and equipment are identified so that compliance can be determined.
	Manufacturer manuals for all installed heating and cooling equipment and service water heating equipment have been provided.
	Insulation R-values and glazing U-factors are clearly marked on the building plans or specifications.
	Duct Insulation:
	Supply ducts in attics are insulated to a minimum of R-8. All other ducts in unconditioned spaces or outside the building envelope are insulated to at least R-6.
	Duct Construction and Testing:
	Building framing cavities are not used as supply ducts.
	All joints and seams of air ducts, air handlers, filter boxes, and building cavities used as return ducts are substantially airtight by means of tapes, mastics, liquid sealants, gasketing or other approved closure systems. Tapes, mastics, and fasteners are rated UL 181A or UL 181B and are labeled according to the duct construction. Metal duct connections with equipment and/or fittings are mechanically fastened. Crimp joints for round metal ducts have a contact lap of at least 1 1/2 inches and are fastened with a minimum of three equally spaced sheet-metal screws. Exceptions:
	Joint and seams covered with spray polyurethane foam.
	Where a partially inaccessible duct connection exists, mechanical fasteners can be equally spaced on the exposed portion of the joint so as to prevent a hinge effect.
	Continuously welded and locking-type longitudinal joints and seams on ducts operating at less than 2 in. w.g. (500 Pa). Duct tightness test has been performed and meets one of the following test criteria:
_	(1) Postconstruction leakage to outdoors test: Less than or equal to 42.6 cfm (8 cfm per 100 ft2 of conditioned floor area).
	(2) Postconstruction total leakage test (including air handler enclosure): Less than or equal to 64.0 cfm (12 cfm per 100 ft2 of conditioned floor area).
	(3) Rough-in total leakage test with air handler installed: Less than or equal to 32.0 cfm (6 cfm per 100 ft2 of conditioned floor area).
	(4) Rough-in total leakage test without air handler installed: Less than or equal to 21.3 cfm (4 cfm per 100 ft2 of conditioned floor area).
•	Temperature Controls:
	Where the primary heating system is a forced air-furnace, at least one programmable thermostat is installed to control the primary heating system and has set-points initialized at 70 degree F for the heating cycle and 78 degree F for the cooling cycle.
	Heat pumps having supplementary electric-resistance heat have controls that prevent supplemental heat operation when the compressor can meet the heating load.
ı	Heating and Cooling Equipment Sizing:
	Additional requirements for equipment sizing are included by an inspection for compliance with the International Residential Code.
	For systems serving multiple dwelling units documentation has been submitted demonstrating compliance with 2009 IECC Commercial Building Mechanical and/or Service Water Heating (Sections 503 and 504).
	Circulating Service Hot Water Systems:
П	Circulating service hot water pipes are insulated to R-2.
	Circulating service hot water systems include an automatic or accessible manual switch to turn off the circulating pump when the system is not in use.
	Heating and Cooling Piping Insulation:
	HVAC piping conveying fluids above 105 degrees F or chilled fluids below 55 degrees F are insulated to R-3.
;	Swimming Pools:
	Heated swimming pools have an on/off heater switch.
	Pool heaters operating on natural gas or LPG have an electronic pilot light.
	Timer switches on pool heaters and pumps are present.
	Exceptions:

Project Title: 94383 13'4"x40' Atco Crew Quarter
Data filename: R:\WIP\2011 WIP\(94383) 13'-4x40' CQ ATCO ALLY\For Colorado\94383 Res-Check.rck

Where public health standards require continuous pump operation.

	Where pumps operate within solar- and/or waste-heat-recovery systems.
	Heated swimming pools have a cover on or at the water surface. For pools heated over 90 degrees F (32 degrees C) the cover has a minimum insulation value of R-12.
	Exceptions:
	Covers are not required when 60% of the heating energy is from site-recovered energy or solar energy source.
L	ighting Requirements:
	A minimum of 50 percent of the lamps in permanently installed lighting fixtures can be categorized as one of the following:
	(a) Compact fluorescent
	(b) T-8 or smaller diameter linear fluorescent
	(c) 40 lumens per watt for lamp wattage <= 15
	(d) 50 lumens per watt for lamp wattage > 15 and <= 40
	(e) 60 lumens per watt for lamp wattage > 40
C	Other Requirements:
	Snow- and ice-melting systems with energy supplied from the service to a building shall include automatic controls capable of shutting off the system when a) the pavement temperature is above 50 degrees F, b) no precipitation is falling, and c) the outdoor temperature is above 40 degrees F (a manual shutoff control is also permitted to satisfy requirement 'c').
С	Pertificate:
	A permanent certificate is provided on or in the electrical distribution panel listing the predominant insulation R-values; window U-factors; type and efficiency of space-conditioning and water heating equipment. The certificate does not cover or obstruct the visibility of the circuit directory label, service disconnect label or other required labels.
NOT	ES TO FIELD: (Building Department Use Only)
	·



Insulation Rating	R-Value		
Ceiling / Roof	38.00		
Wall	21.00		
Floor / Foundation	38.00		
Ductwork (unconditioned spaces):			
Glass & Door Rating	U-Factor	SHGC	
Window	0.29	0.29	
Door	0.35	NA	
Heating & Cooling Equipment	Efficiency		
Heating System:			
Cooling System:			
Water Heater:			
No.	Date:	-34	
Name:	Date:		

Comments: